




Site Plan
Scale 1:7500

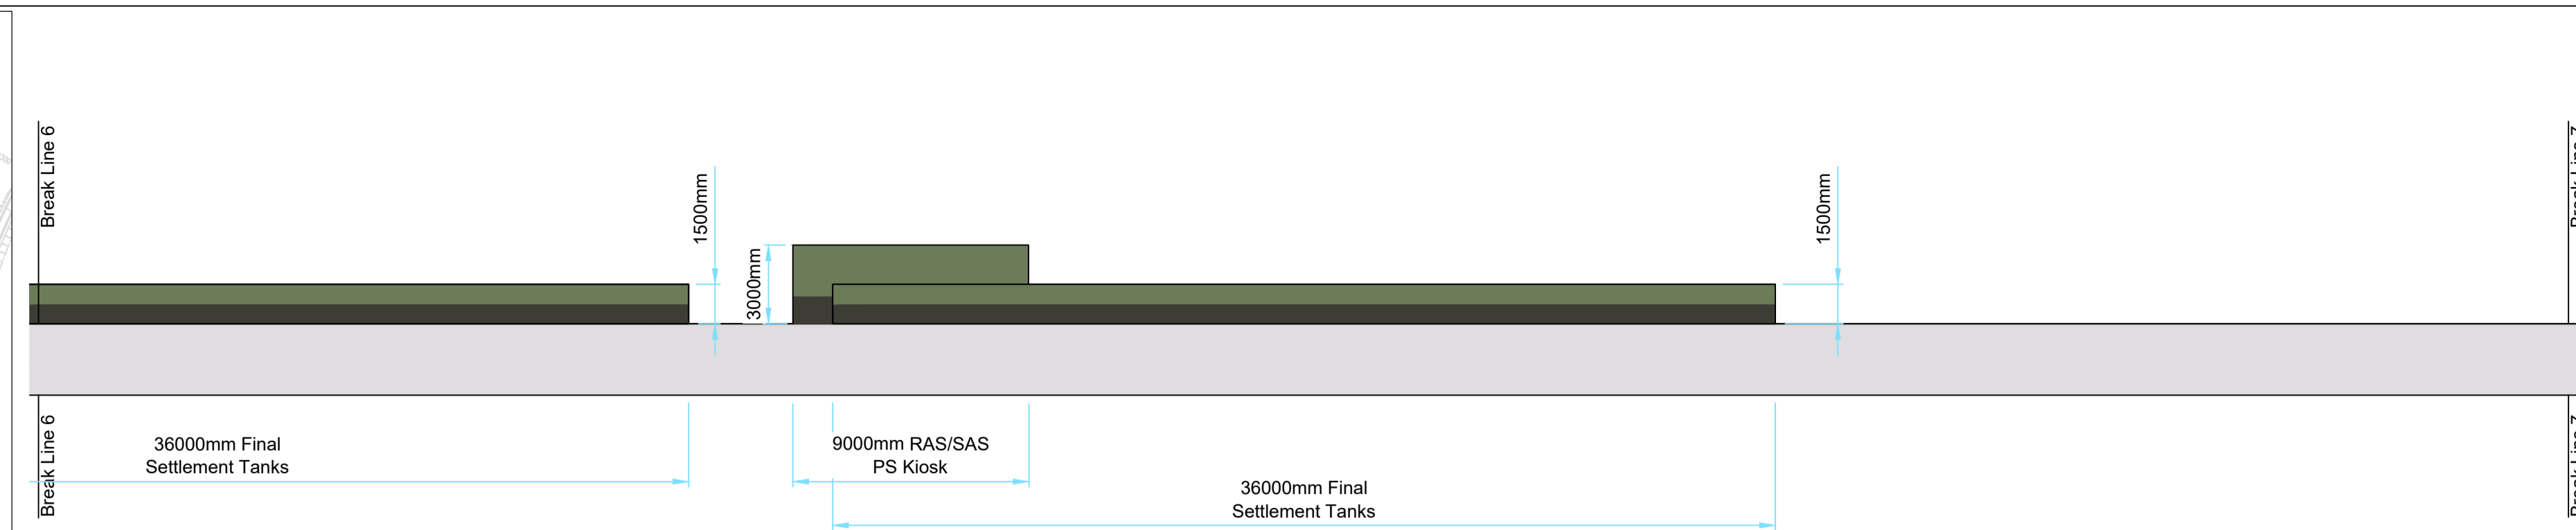


Sectional Elevation - Cut 2
Scale 1:200

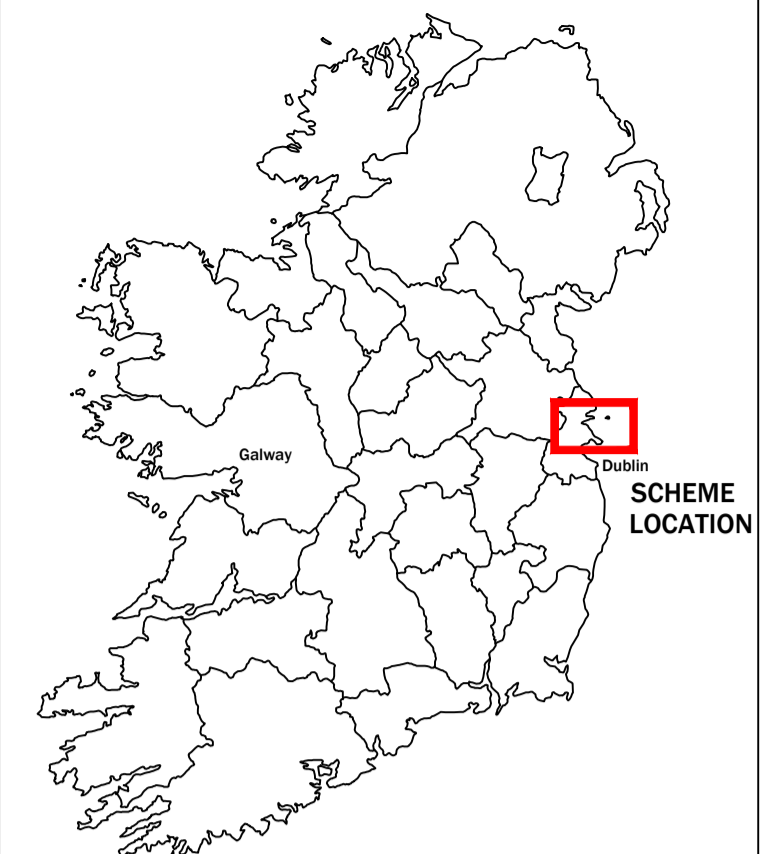

- Notes:**
1. This drawing is not to be scaled. Figured dimensions only to be taken.
 2. The Process type and arrangement shown requires confirmation by outline design.
 3. 38kV Power line passes through the proposed land boundary. It is assumed that the power line to be re-routed around site boundary.
 4. All earthworks shall be at a maximum slope of 1V : 2H.
 5. All tanks shall be covered with GRP clam shell covers.
 6. All drawings to be checked by the Contractor on Site.
 7. Engineer to be informed by the Contractor of any discrepancies before any work commences.
 8. All levels shown relate to Ordnance Survey datum at Malin Head, the geographic coordinate system is to Irish Transverse Mercator (ITM).
 9. UV building's dimensions and the dimension is taken from a cut through the building based on its orientation.

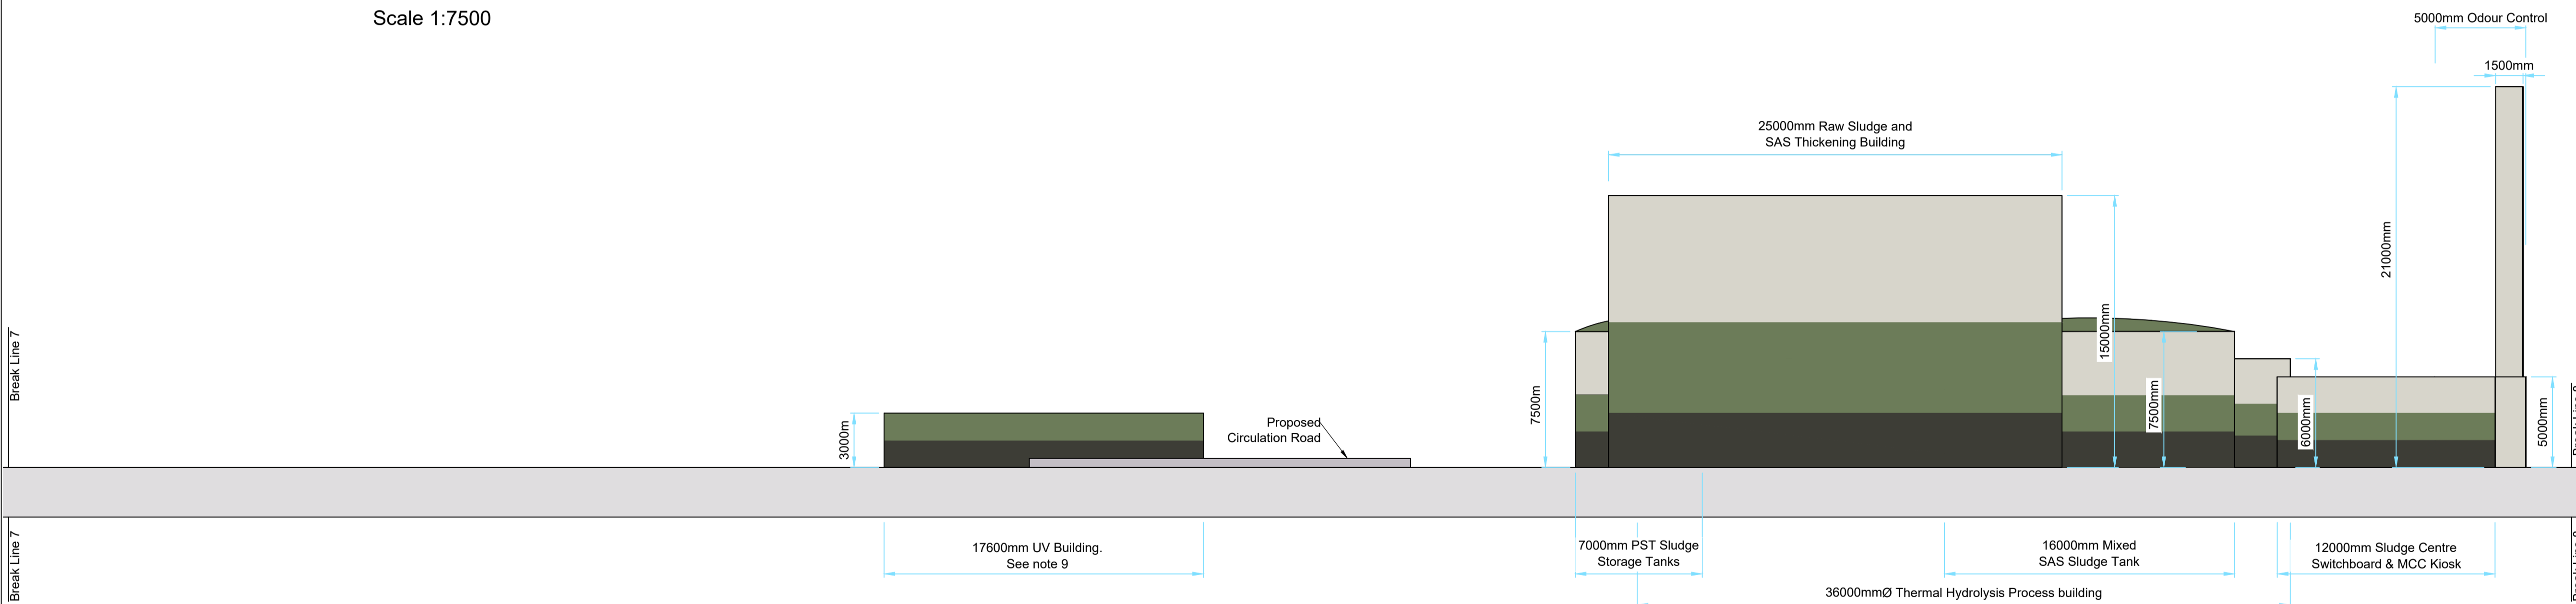

Sectional Elevation - Cut 2
Scale 1:200

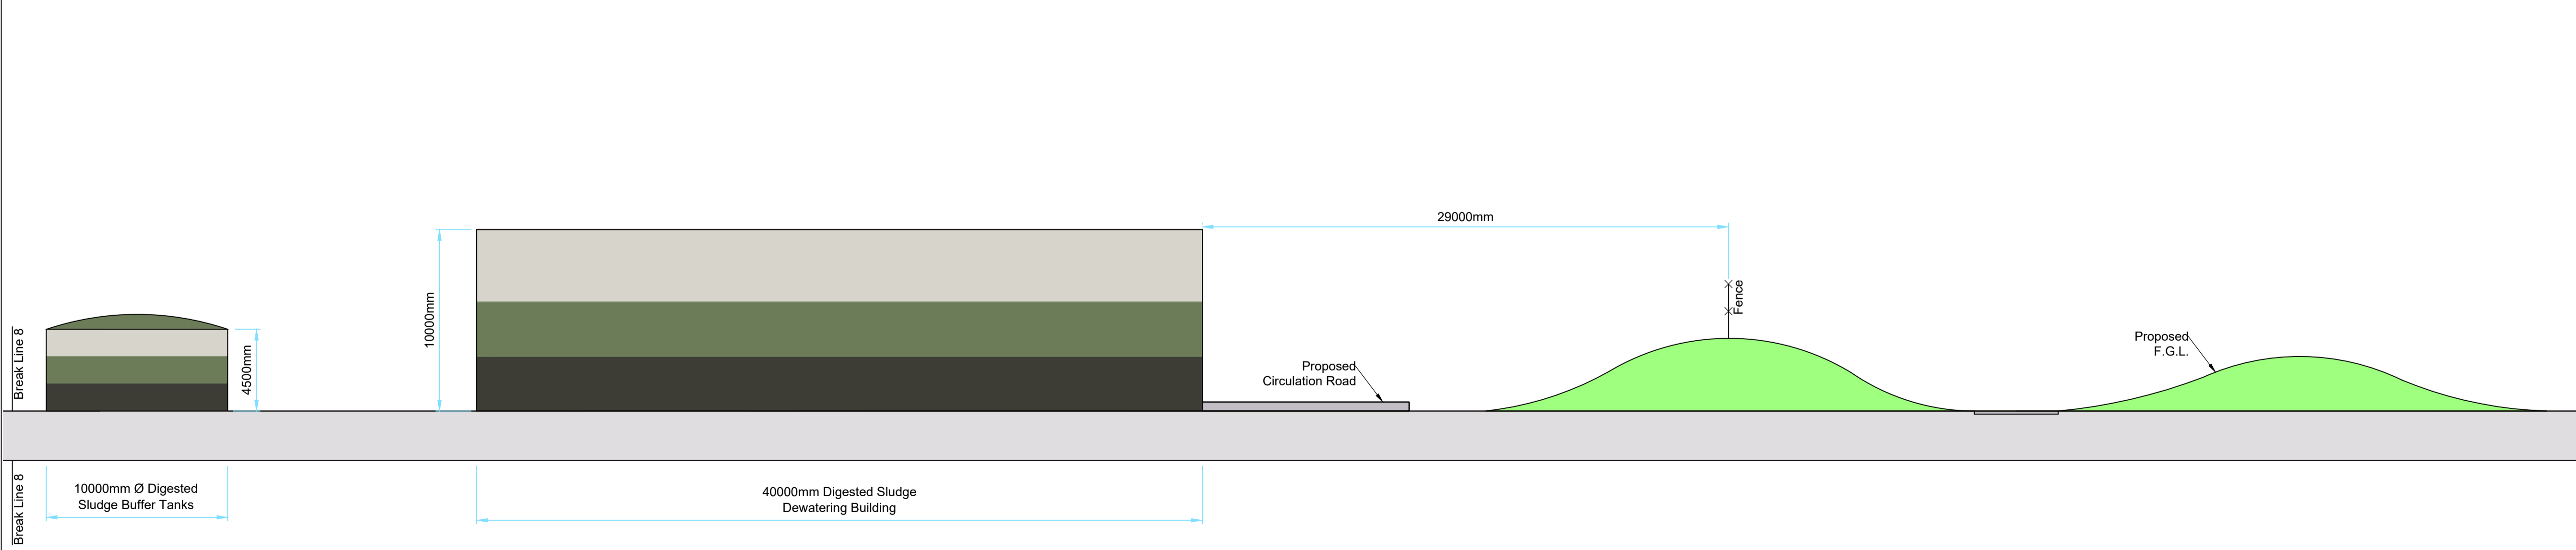

Sectional Elevation - Cut 2
Scale 1:200

| Rev | Date | Description | By | Chkd. |
|-----|----------|------------------------------|----|-------|
| P02 | 09.10.23 | Issued for Planning Remittal | MP | DA |
| P01 | 15.12.22 | Issued for Planning Addendum | MP | MON |



Client:
Uisce Éireann
Irish Water

Project:
GREATER DUBLIN DRAINAGE PROJECT

Drawing Title:
REGIONAL WwTP
SECTIONS ASP OPTION
SECTIONAL ELEVATION - CUT (SHEET 3 OF 3)

Scale @ A1 (DO NOT SCALE); AS SHOWN @ A1

Prepared by: M. Paprota
Checked: M. O'Neill
Date: 15-12-22

Project Manager: Jillian Bolton

Jacobs Number: 32102902

Drawing Status: Issued for Planning Remittal

Jacobs

This drawing is not to be used in whole or part other than for the intended purpose & project as defined on this drawing. Refer to the contract for full terms and conditions.

Drawing No.: 32102902-2137

Revision: P02